



- 2. FUSESAVER TO BE INSTALLED ON THE LOAD SIDE OF THE EDO.
- 3. FOR SITES WITH AN EXISTING GBS REFER SHEET 3.

	AMENDMENTS				
NO	DESCRIPTION	DRN	DATE	CKD	APPD
0	ISSUED FOR CONSTRUCTION	C.C.	MAY'16	A.T.	B.C.
1	TITLEBLOCK & DRAWING NUMBER FORMATTED	K.T.	JAN'19	C.C.	C.C.
2	REDRAWN, MATERIAL SCHEDULE UPDATED, NOTES 1&2 UPDATED, NOTE 3 ADDED.	C.C.	FEB'21	H.E.	B.V.



4)-	2	3 1 (C) +++++++ (D) 17 SECTION 2 1:20	10 19	
25	3	ALUMINIUM BAIL LIVE LINE CLAMP	239020	S01-01-04-10
24	3	LIVE LINE CLAMP	2121	S01-01-04-17
23	12	LUGS TO SUIT ITEM 22 70mm TYPE E	406766	S02-01-02-11
22	AR	FLEX CU INSULATED 70SQmm CABLE	406718	S02-01-01-34
21	3	HV EDO OR HV LINK ASSEMBLY REFER NOTES 1 & 3	3863 2204	S01-01-06-06 S01-01-06-07
20	1	FIBREGLASS EDO CROSSARM	298547	S01-01-02-10
19	AR	OVERHEAD CONDUCTOR	-	-
18	6	TONGUE HOOK	292680	S01-01-03-09
17	6	THIMBLE CLEVIS	6767	S01-01-03-09
16	3	M24 BOLT 65mm LONG	400800	S01-01-04-43
15	6	M16 SPRING WASHER	114 322	S01-01-04-43
14	5	M24 SPRING WASHER	114 3 3 0	S01-01-04-43
13	12	M16 FLAT SQUARE WASHER	114348	S01-01-04-43
12	10	M24 FLAT SQUARE WASHER	298828	S01-01-04-43
11	2	M24 HV STUD 165/30mm	500500	S01-01-04-44
10	3	PALM PG CLAMP DISCONNECT TEE	2295	S01-01-04-10
9	2	ANGLE CROSSARM BRACE	400815	S01-01-04-38

**SECTION 3** 

114561

298687

400802

298711

414398

406938

292656

ITEM NUMBER

S01-01-04-43

S01-01-04-38

501-01-04-43

S01-01-04-41

S01-01-02-10

S01-01-04-37

S01-01-06-18

S01-01-03-09

DWG No.

MATERIAL SCHEDULE

M16 BOLT AND NUT 180mm LONG

22kV 70kN SUSPENSION INSULATOR

FIBREGLASS HV TERMINATION CROSS ARM 125×125mm

CROSSARM BRACE FLAT

M24 BOLT 180mm LONG


18kN EYE NUT

HV STRAIN PLATE

22kV FUSESAVER

ITEM QTY DESCRIPTION

DES	DES A.TAYLOR POWER STANDARD DRAWING				
DRN	C.COPPINS		HGEAR		
CKD	I.BASHIR	FUSES			
APPD			INSTALLATION 10F3		
SCALE	AS SHOWN	5	10. 5		
ISSUED MARCH 2015 ALL DIM. IN mm		А3	DRAWING	S01-02-07-17 1	$\wedge$
		AS	NUMBER	301-02-07-17_1	/2\
DRAFTING STANDARD TO A.S.1100		A.S.1100	CAD PRODU	T - DO NOT AMEND MANUALLY	AMDT

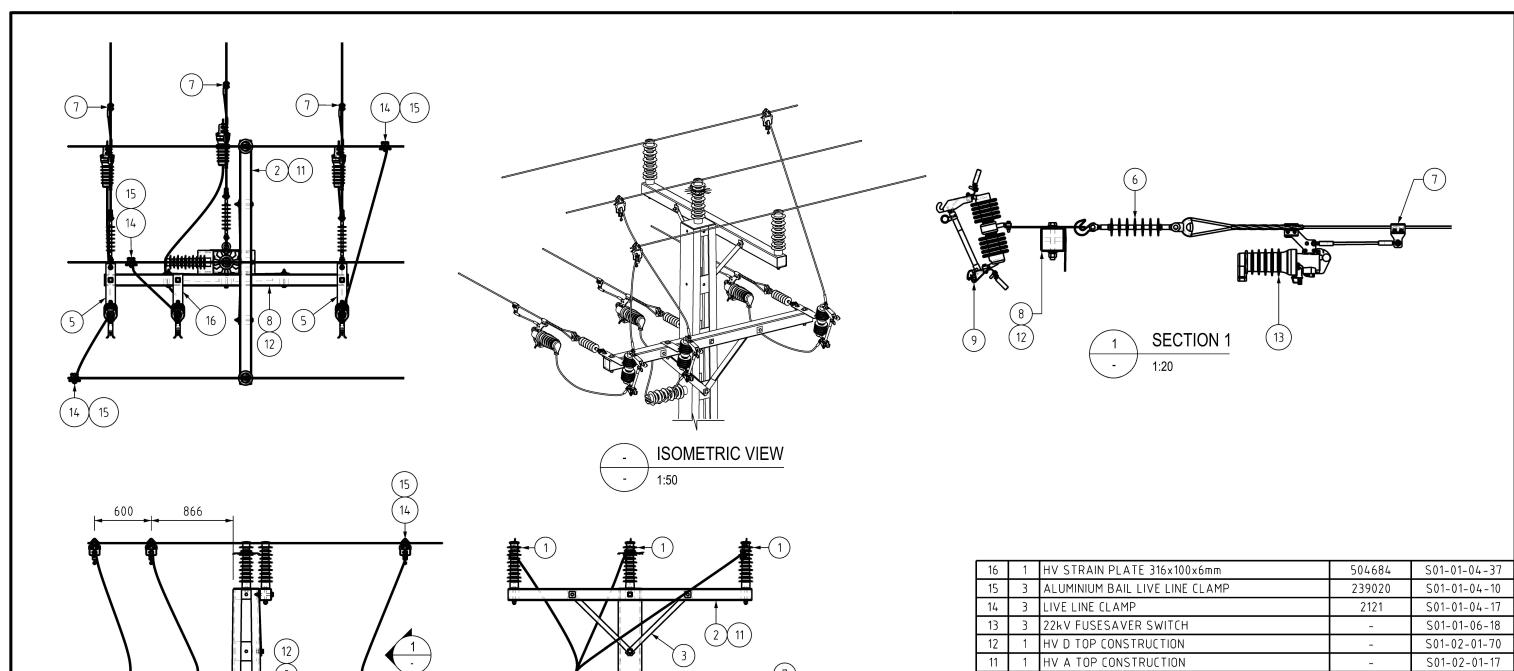

SIDE ELEVATION

16	1	HV STRAIN PLATE 316x100x6mm	504684	S01-01-04-37
15	3	ALUMINIUM BAIL LIVE LINE CLAMP	239020	S01-01-04-10
14	3	3       ALUMINIUM BAIL LIVE LINE CLAMP       239020         3       LIVE LINE CLAMP       2121         3       22kV FUSESAVER SWITCH       -         1       HV D TOP CONSTRUCTION       -         1       HV A TOP CONSTRUCTION       -         1       UNIVERSAL LINE POLE       -         3       HV EDO OR HV LINK ASSEMBLY REFER NOTES 1&3 ON SHEET 1       3863 2204         1       CROSSARM HV TERMINATION FIBREGLASS       414398         3       PALM PG CLAMP DISCONNECT TEE       2295         3       22kV 70kN POLYMER SUSPENSION INSULATOR       292656         2       HV STRAIN PLATE 426x100x6mm       504683		S01-01-04-17
13	3	22kV FUSESAVER SWITCH	-	S01-01-06-18
12	1	HV D TOP CONSTRUCTION	-	S01-02-01-70
11	1	HV A TOP CONSTRUCTION	-	S01-02-01-17
10	1	UNIVERSAL LINE POLE	-	1
9	3			S01-01-06-06 S01-01-06-07
8	1	CROSSARM HV TERMINATION FIBREGLASS	414398	S01-01-02-10
7	3	PALM PG CLAMP DISCONNECT TEE	2295	S01-01-04-10
6	3	22kV 70kN POLYMER SUSPENSION INSULATOR	292656	S01-01-03-09
5	2	HV STRAIN PLATE 426x100x6mm	504683	S01-01-04-37
4	2	CROSSARM BRACE ANGLE	400815	S01-02-01-49
3	2	CROSSARM BRACE FLAT	298687	S01-02-01-49
2	1	CROSSARM HV LINE FIBREGLASS	298802	S01-01-02-10
1	4	INSULATOR CYCLOALIPHATIC VERTICAL LINE POST	300467	S01-01-03-10
ITEM	QTY	DESCRIPTION	ITEM NUMBER	DWG NUMBER
		MATERIAL COUEDING		


MATERIAL SCHEDULE

	C.C. C.C. I.B. B.C.
NO DESCRIPTION DATE	CKD APPD
NO DESCRIPTION DATE  AMENDMENTS	CKD APPD

FRONT ELEVATION




DES	DES A.TAYLOR POWER STANDARD DRAWING				
			HGEAR		
CKD B.NARAYANA		FUSES			
APPD B.CHEUNG			INSTALLATION 2 OF 3		
SCALE AS SHOWN		5	2 01 3		
ISSUED NOV'14		A3	DRAWING	S01-02-07-17 2 /	$\overline{\ }$
ALL DIM. IN mm		AD	NUMBER	301-02-07-17_2 /	2
DRAFTING STANDARD TO A.S.1100			CAD PRODUC	T - DO NOT AMEND MANUALLY AM	ID T

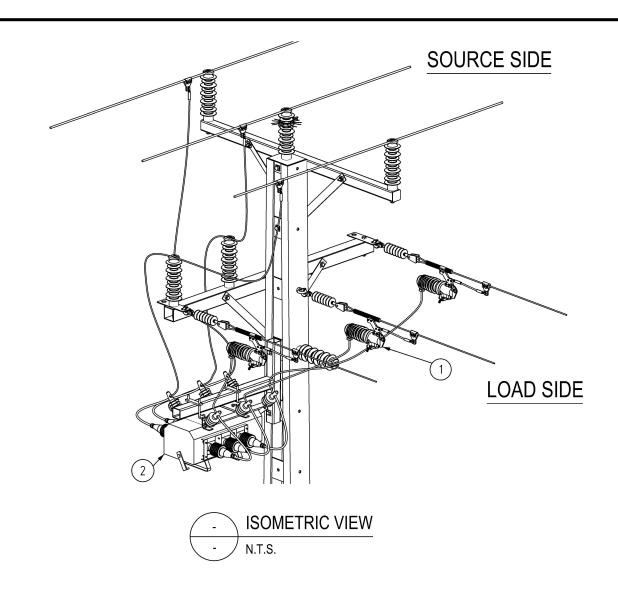

GBS-FUSESAVER T-OFF INSTALLATION

## NOTES:

1. FOR OPEN-CLOSE-OPEN OCO FUSESAVER INSTALLATION ALONG WITH A MID-POLE GBS ONLY. 2. REFER TO STD DWG S01-02-07-11 AND S01-02-07-18 FOR THE GBS INSTALLATION DETAILS.

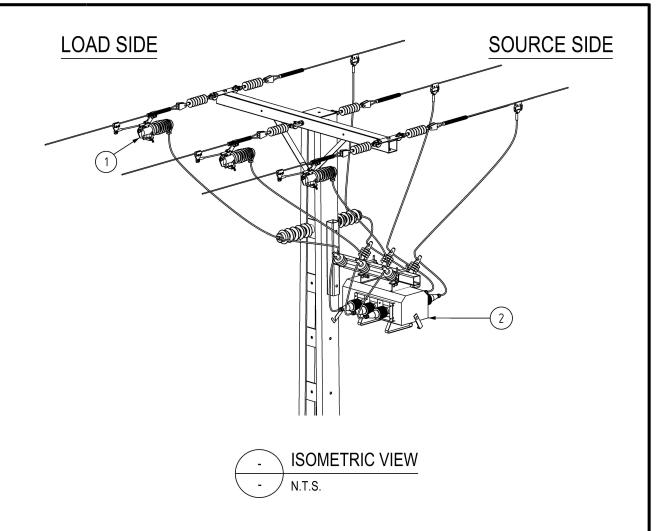

GBS-FUSESAVER INLINE INSTALLATION

**DES** H.ETESAMI

2	GAS LOAD BREAK SWITCH GBS	ı	S01-01-06-17
1	22kV FUSESAVER SWITCH OCO CONFIGURATION	ı	S01-01-06-18
ITEM	DESCRIPTION	ITEM No.	DWG NUMBER

MATERIAL SCHEDULE

POWER STANDARD DRAWING

NO	DESCRIPTION AMENDMENTS	DRN	DATE	CKD	APPD
0	ISSUED FOR CONSTRUCTION	C.C.	FEB'21	H.E.	B.V.



DRAFTING STANDARD TO A.S.1100			(AD PR	ODUCT - DO NOT AMEND MANUALLY	AMDT
ALL DIM. IN mm		Α3	NUMBER SUI-UZ-UT-TT_		<u> </u>
ISSUED FEBRUARY 2021		۸٦	DRAWING	S01-02-07-17 3	
SCALE AS SHOWN		5	3 0. 3		
APPD B.VANDERSTELT			3 OF 3	NSTALLATION	
			AVER	NC TALLATION	
DRN C.COPPINS SWITCHGEAR					